

# 5

## Planning Commission Study Session

TO: PLANNING COMMISSION / DESIGN REVIEW BOARD

FROM: STEPHANIE BUBENHEIM, PLANNER II

(480) 503-6625, STEPHANIE.BUBENHEIM@GILBERTAZ.GOV

THROUGH: CATHERINE LORBEER, AICP, PRINCIPAL PLANNER

(480) 503-6016, CATHERINE.LORBEER@GILBERTAZ.GOV

**MEETING DATE: APRIL 1, 2020** 

SUBJECT: DR20-47, BUSHTEX

STRATEGIC INITIATIVE: Exceptional Built Environment

To allow for the expansion of an existing satellite transmission company.

## **REQUEST**

DR20-47, Bushtex: site plan, landscape, grading and drainage, elevations, floor plans, lighting, colors and materials for approximately 3.15 acres, generally located east of the southeast corner of Cooper and Guadalupe Roads and zoned Light Industrial (LI).

## **RECOMMENDED MOTION**

Request for input only. No motion required.

APPLICANT OWNER

Company: Helmut John Hammen Architect LLC Company: Kamalei Properties LLC

Name: John Hammen Name: Adelaida Severson

Address: 8337 E. Monterey Way Address: 723 W. Guadalupe Road

Scottsdale, AZ 85251 Gilbert, AZ 85233

Phone: 602-758-7437 Phone: 480-471-6688

Email: helmutjohn@hotmail.com Email: adeliada@bushtex.com

## **BACKGROUND/DISCUSSION**

## **History**

Date	Description
April 8, 1974	Town Council adopted Ordinance No. 154 and annexed land into
	the Town of Gilbert limit including the subject site.
Between 1969-1976	The main office structure was built as a single-family residence on
	the subject site.
Between 1976-1993	Other structures are built on the property.
February 23, 2011	Staff approved an Administrative Design Review to update the
	retention on site and construct a new screen wall.
April 11, 2011	Staff approved an Administrative Design Review for an addition to
	the main office; addition was not built.

## Overview

The applicant is seeking approval of a new warehouse/office building on an existing industrial site operated by Bushtex, a satellite telecommunications facility. The site is 3.15 acres and is currently developed with a main office (previously a single-family house), a modular office building, storage building, and metal warehouse building used for satellite repairs. The applicant is redesigning the site to demolish all buildings aside from the main office to build a new 19,840 square foot manufacturing, warehouse, and 2-story office facility to accommodate the expanding company.

The site is located at 723 W. Guadalupe Road east of the southeast corner of Cooper and Guadalupe Roads. The site has two existing access points on Guadalupe Road, one full motion and one right in/right out, that were recently reconstructed with ST094 capital improvements project to widen Guadalupe Road.

**Surrounding Land Use & Zoning Designations:** 

	<b>Existing Land Use</b>	<b>Existing Zoning</b>	<b>Existing Use</b>		
	Classification				
North	Neighborhood	Neighborhood	Casa De Cooper		
	Commercial	Commercial (NC) PAD	commercial center		
South	Utility/Transportation	Public	Railroad and industrial		
	Light Industrial	Facilities/Institutional	uses		
East	Light Industrial	Light Industrial (LI)	Industrial storage yard		
West	Light Industrial	Light Industrial (LI)	Vehicle services business		
Site	Light Industrial	Light Industrial (LI)	Bushtex		

**Project Data Table** 

Site Development Regulations	Required per LDC	Proposed LI
Maximum Building Height (ft.)/(Stories)	55'	32'
Minimum Building Setback (ft.)		
Front	30'	55'
Side (Employment)	0'	44'

Rear (Public	15'	90'
Facility/Institutional)		
Separation Between Buildings (ft.)	20'	24'
Minimum Required Perimeter		
Landscape Area (ft.)		
Front	25'	0' (existing)
Side (Employment)	5'	5' or 0' within an
		enclosed service yard
Rear (Public	15'	5' or 0' within an
Facility/Institutional)		enclosed service yard
Landscaping (% of net lot area)	N/A	14.3%
Parking	Warehouse 1 sp/1000 sf	57 spaces provided
	=7 spaces	
	Light Manufacturing	
	1 sp/500  sf = 14  spaces	
	Office 1 sp/250 sf = 41	
	spaces	

## **DISCUSSION**

The project is currently in first review and therefore additional comments, beyond what are included in this report, may be brought forward for discussion during the study session meeting.

#### Site

As part of this design review, all existing buildings, not including the main office building along Guadalupe Road, will be demolished to make room for the new proposed warehouse/office building. The majority of the site is an industrial service yard and gated from the public; one gate on the east side of the property exists with a parking lot along Guadalupe Road frontage. The existing parking lot along Guadalupe Road and property line were recently modified during the widening of Guadalupe Road with ST094 and the parking lot is non-conforming to current LDC development standards for landscape requirements. As it is an existing parking lot, changes to this area will not be required as part of this design review. One additional gated entrance to the service yard is proposed on the west side of the property and will create a looped roadway around the new building. The 19,840 square foot building is "L shaped" and will be located to the west of the main office building.

#### Landscape

The site has some existing landscape to the north of the service yard wall. Additional landscape is proposed to meet landscape requirements including the addition of Mondel Pines, the street theme tree for the area. Landscape is not proposed behind the service yard wall as it is not required within fully enclosed industrial service yards. *1st review comments include modifying the landscape plan to reflect the existing right-of-way improvements*.

## **Grading and Drainage**

As part of the CIP project ST098, a storm drain for street run-off was built on this site and flows to the retention basin at the southwest end. The proposed grading and drainage plan generally meets the requirements of the Town of Gilbert's Engineering Division.

## **Elevations, Floor Plan, Colors and Materials**

The new building will be constructed from concrete tilt panel and stucco in a modified "L" shape. The two main body colors of the building will be light beige's "Ivoire" and "Independent Gold". The colors are similar to the existing main office building. The lower base of the building is a darker shade to help visually ground the building. The north elevation that will be seen along Guadalupe road will house the 2-story office section and has windows on both stories. Metal accents are shown over some windows. Wing walls are proposed at the sides of the building and at the middle of the north elevation to provide movement. The west elevation has recessed segments and floor to ceiling windows are proposed at the in-seam of the projected segments of wall panels to provide articulation. Two 6" bands wrap around the building to provide horizontal movement. The internal east elevation will have loading docks and is internal to the site behind the service yard screen wall.

The height of the parapet is at 30' with wing walls reaching 32' in height. The floor plan shows a 2-story office along the north elevation with a warehouse at the rear. 1st review comments include revising the 2D elevations to better illustrate the color changes and exploring ways to add variety to the color of the building and providing metal canopies over windows that are proportionate in size to the mass of the building.

## Lighting

There are only three lighting types proposed: parking lot, building wall mounted, and recessed lighting at the loading dock. Building mounted lighting is proposed at 14' height. *Ist review comments include adjusting the parking lot lighting to meet town codes for location and level of illuminance.* 

## Signage

Signage is not included in this approval. Administrative Design Review approval is required prior to permitting for any proposed monument signage.

The applicant has requested construction document (cd) at-risk. Staff would only support cd at-risk if the applicant is able to address all Planning Commission comments and 2<sup>nd</sup> review comments prior to cd submittal.

## PUBLIC NOTIFICATION AND INPUT

The proposed project will require public notice as specified under Land Development Code (LDC) Section 5.602.A.3.

## **REQUESTED INPUT**

1. Colors, materials, and articulation of the building

Respectfully submitted.


Stephanie Bubenheim

Planner II


## **Attachments and Enclosures:**


- Vicinity Map
   Aerial Photo
- 3) Site Plan
- 4) Demo Plan
- 5) Landscape6) Grading and Drainage7) Colors and Materials
- 8) Elevations
- 9) Floor Plans
- 10) Lighting

# DR20-47 BushTex Building Vicinity Map

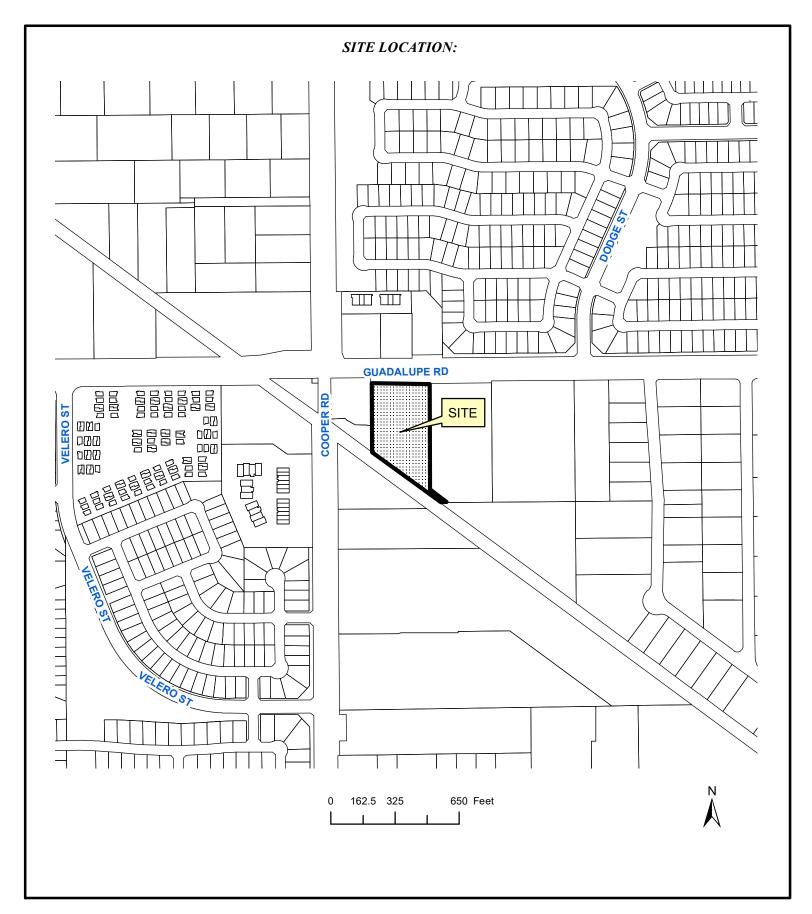

## DR20-47 Bushtex **Attachment 2: Aerial Photo**

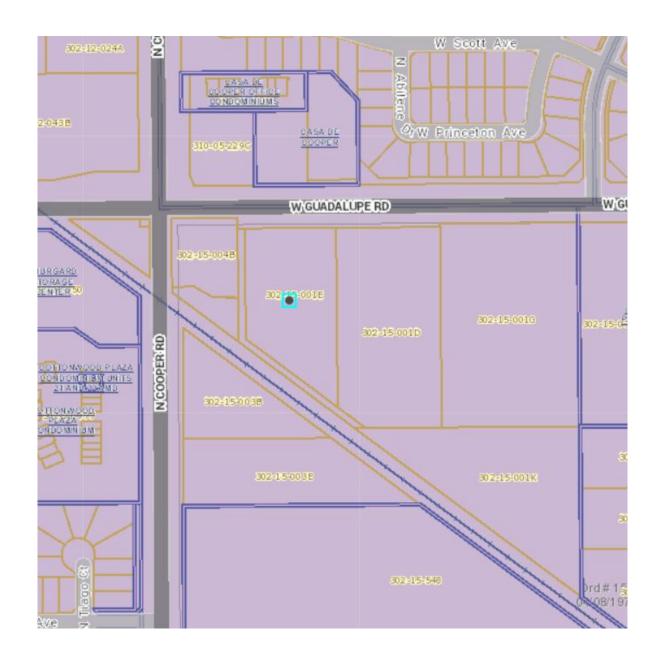

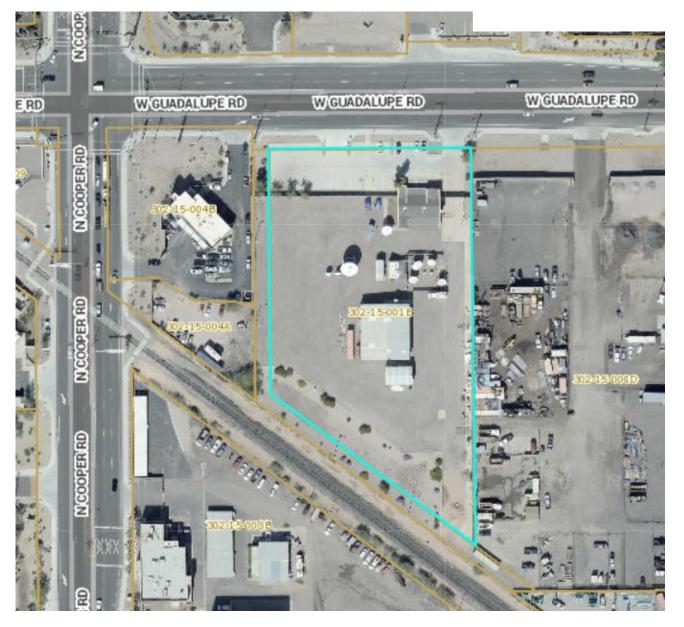



## DESIGN REVIEW AND PRELIMINARY PRICING ONLY. NOT FOR CONSTRUCTION OR PERMITTING



PROJECT NUMBER: 191953




BUSHTEX BUILDING



SHEET TITLE
PARCEL/ARIAL
MAP

G101

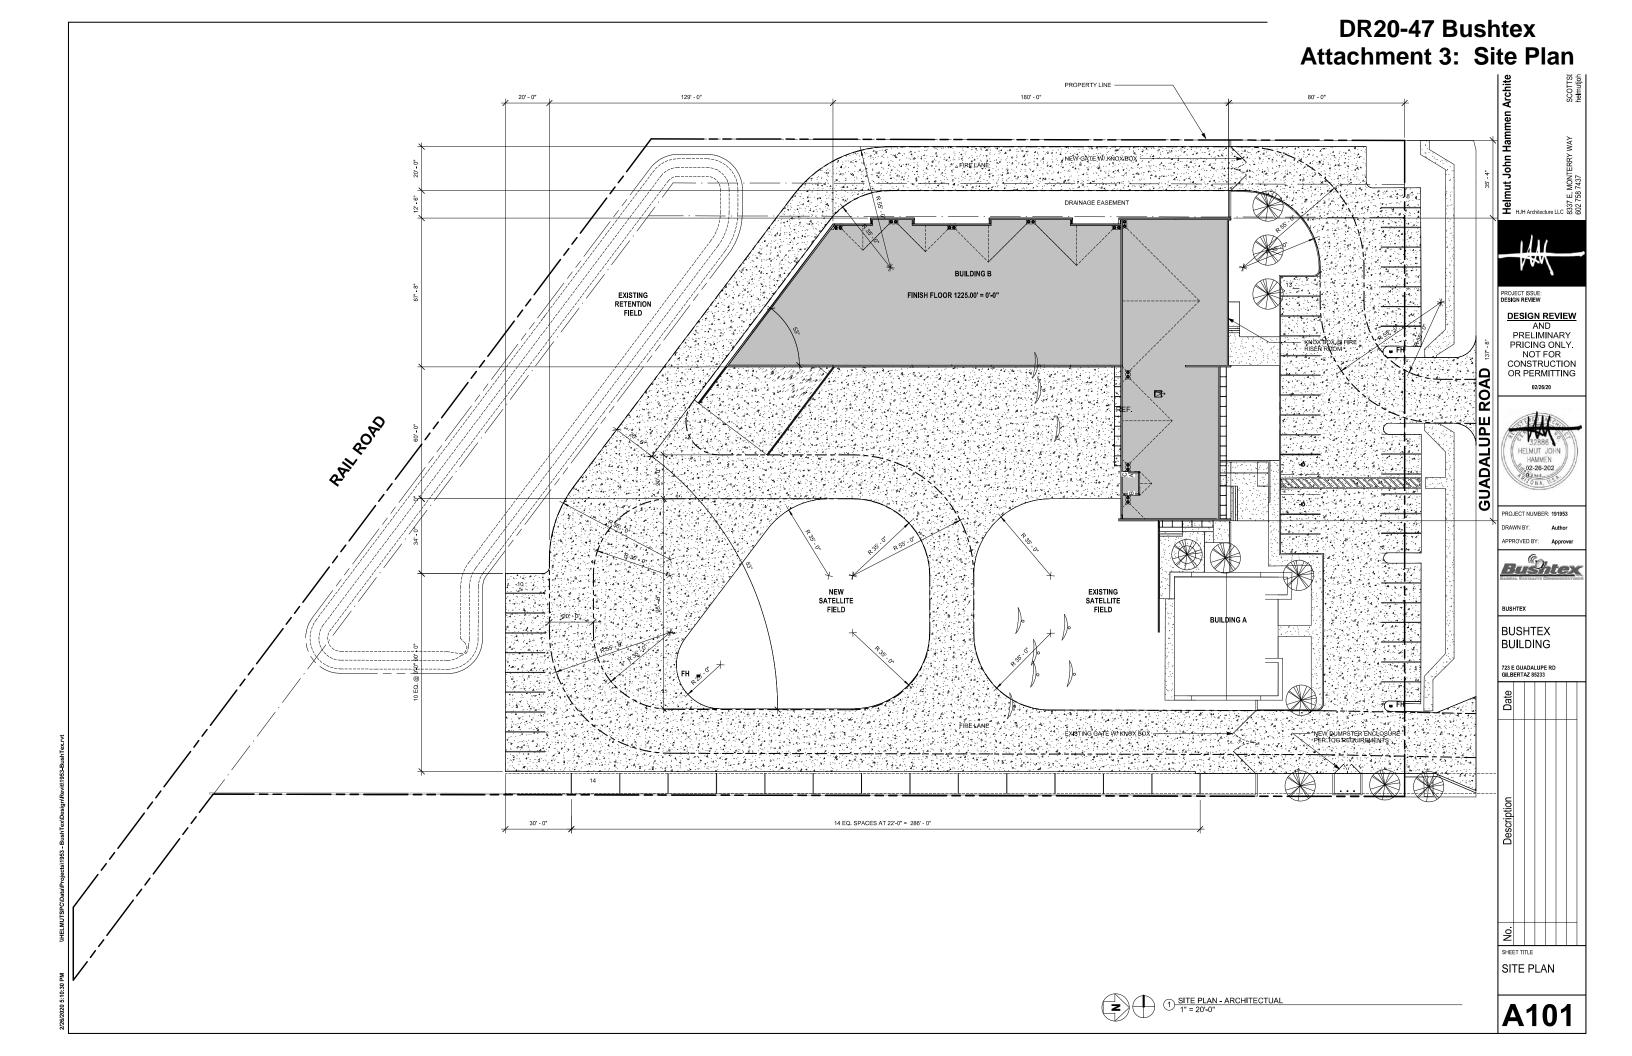



## **BUSHTEX BUILDING**

## 723 W GUADALUPE ROAD, GILBERT AZ 85233



## **PROJECT DATA**

SCOPE OF WORK: MUNICIPALITY: TOWN OF GILBERT PROJECT ADDRESS 723 W GUADALUPE ROAD GILBERT AZ 85233

ALL WORK SHALL CONFORM TO ALL APPLICABLE GOVERNING CODES, INCLUDING, BUT NOT LIMITED TO THE LATEST EDITIONS OF THE FOLLOWING: GOVERNING CODES:

2018 I.B.C. (INCLUDING AMENDMENTS) ELECTRICAL 2018 N.E.C. (INCLUDING AMENDMENTS) MECHANICAL 2018 LM C. (INCLUDING AMENDMENTS) 2018 I.P.C. (INCLUDING AMENDMENTS) 2018 J.F.C., 2010 NFPA (INCLUDING AMENDMENTS) 2010 ADA STANDARDS FOR ACCESSIBLE DESIGN ACCESSIBILITY:

ENERGY 2018 I.E.C.C. ΔΡΝ-302-15-001E ZONING LL(LIGHT INDUSTRY) BUILDING AREA 19.840 SQ. FT.

FACTORY (F) STORAGE (S) OFFICE (B)

CONSTRUCTION TYPE TYPE II-B

6,770 SQ. FT. / 100 SQ. FT. PER OCCUPANT OCCUPANT LOAD:

= 68 OCCUPANTS 6,770 SQ, FT. / 500 SQ, FT. PER OCCUPANT = 14 OCCUPANTS 6,300 SQ, FT. / 150 SQ, FT. PER OCCUPANT = 42 OCCUPANTS

TOTAL = 124 OCCUPANTS

2,270 SF 5,390 SF 2,700 SE 10,360 SF

MINIMUM EXITS REQUIRED: 2 EGRESS CALCULATION:

EXITS PROVIDED: 4
TWO EXISTING EXIT STAIRS PROVIDE 72" MINIMUM EGRESS WIDTH

57 SPACES 57 SPACES

STANDPIPES: YES YES FIRE SPRINKLERS: FIRE ALARMS:

**PARKING** 

BLDG B - 1ST FLOOR TOTAL WAREHOUSE PARKING:

WAREHOUSE (S-1) REQUIRED MANUFACTURING (F-1) REQUIRED OFFICE (B) REQUIRED TOTAL PARKING REQUIRED TOTAL PARKING PROVIDED

ACCESSIBLE PARKING REQUIRED ACCESSIBLE PARKING PROVIDED

FIRE EXTINGUISHERS: INSTALLED PER IFC 906 AND NFPA 10

## **DRAWING INDEX**

## PROJECT DIRECTORY

BUSHTEX SATELLITE
723 E GUADALUPE RD
GILBERT AZ 85233
ADELAIDA SEVERSON
PH: 480 471 6688
adelaida@bushtex.com

LANDCOR CONSULTING

LANDCOR CONSULTING 6899 E REMBRANT AVE #124 MESA AZ 85212 WADE COOKE PH: 480 223 8573 wade@landcorconsulting.com

HARRINGTON PLANNING + DESIGN 1921 S ALMA RD #204 MESA AZ 85210

JASON HARRINGTON PH: 480 250 0116 jason@harringtonplanningdesign.com

STRUCTURAL ENGINEERING EXCELLENCE INC. 2931 E POWELL WAY GILBERT AZ 85298 DEREK HANSON PH: 480 414 5051

HELMUT JOHN HAMMEN ARCHITECTURE LLC 8337 EAST MONTEREY WAY SCOTTSDALE AZ 85251 JOHN HAMMEN PH: 602 758 7437 helmutjohn@hotmail.com BORUM + MARTIN LLC

ARCHITECT:

MECHANICAL/PLUMBING:

10201 S 51ST ST #125 PHOENIX AZ 85044 JASON BORUM PH: 602 475 8702 jason@borummartin.co

ELECTRICAL

EDESIGN GROUP LLC 2415 E CAMELBACK RD #700 PHOENIX AZ 85016 PAUL HALUM P.E. PH: 602 560 3344 paulh@edesigngroup.org

## **PROJECT NARRATIVE**

THE PROJECT CONSIST OF DEMOLISHING SEVERAL EXISTING BUILDINGS. THE EXISTING MAIN BUILDING WILL REMAIN. A NEW BUILDING WILL BE USED FOR LIGHT MANUFACTURING, OFFICE AND WAREHOUSE.

## **DEFERRED SUBMITTALS**


FIRE SPRINKLER SCOPE AND ALL LIFE SAFETY DEVICES AND FIRE SPRINKLER SCOPE AND ALL LIFE SAFETY TO EVICES AND ALARM ARE REQUESTED TO BE CONSIDERED FOR DEFERRED SUBMITTAL STATUS. STOREFRONT CALCULATIONS ARE ALSO REQUESTED TO BE CONSIDERED FOR DEFERRED SUBMITTAL STATUS.

## **LOCATION MAP**



PROJECT LOCATION:

723 E GUADALUPE ROAD GILBERT AZ 85233

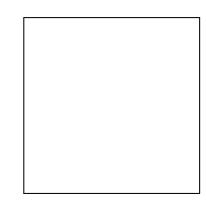



**DESIGN REVIEW** AND PRELIMINARY PRICING ONLY. NOT FOR

OR PERMITTING

CONSTRUCTION



PROJECT NUMBER: 191953

PPROVED BY:




BUSHTEX BUILDING

723 E GUADALUPE RD GILBERTAZ 85233

Description			
No			

G100

**COVER SHEET** 

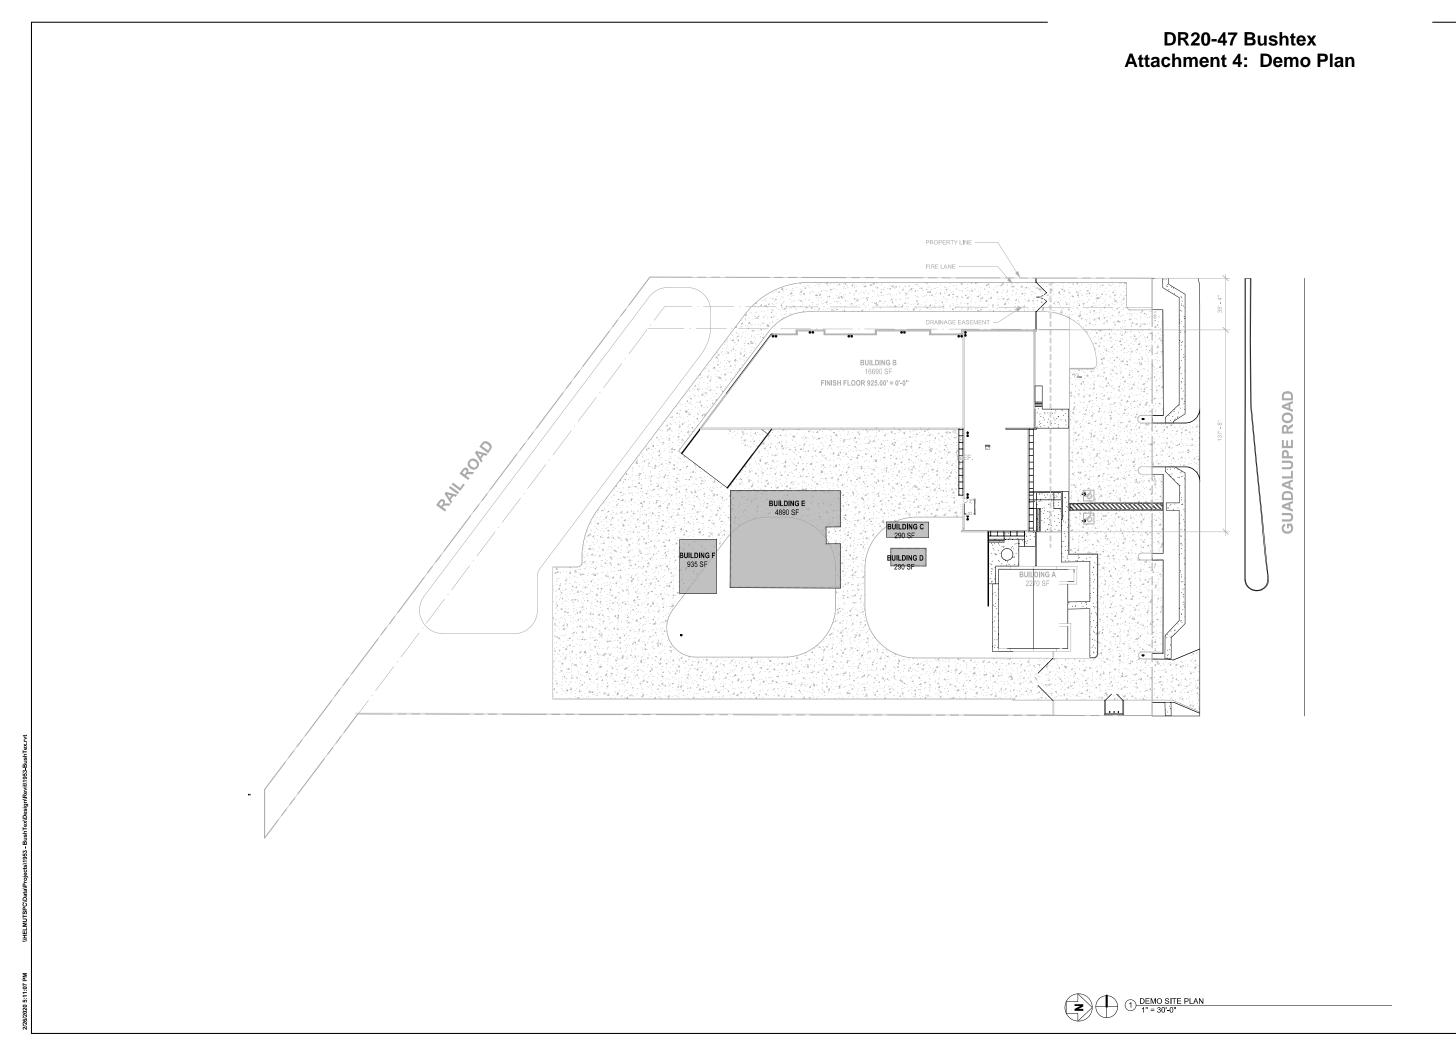

SCOTTSDALE AZ 8525 helmuljoin@hotmail.cor

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PROJECT ISSU DESIGN REVIEN

DESIGN REVIEW
AND
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NOT FOR
CONSTRUCTION
OR PERMITTING

02/26/20



PROJECT NUMBER: 191953

DRAWN BY: Author

APPROVED BY: Approver



BUSHTE


BUSHTEX BUILDING

723 E GUADALUPE RD GILBERTAZ 85233



SHEET TITLE
DEMO SITE
PLAN

D101

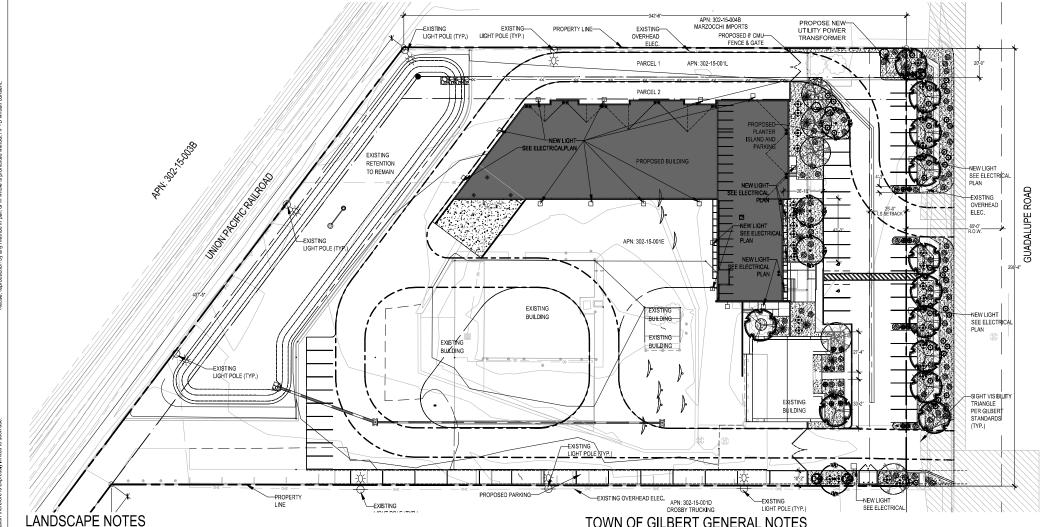

- PERFORM WORK IN ACCORDANCE WITH THESE PLANS, DETAILS, AND SPECIFICATIONS.
- CAREFULLY INSPECT SITE AND VERIFY CONDITIONS PRIOR TO BIDDING. NOTIFY LANDSCAPE ARCHITECT OF DISCREPANCIES WITH THESE DOCUMENTS PRIOR TO BEGINNING CONSTRUCTION. IT SHALL BE THE CONTRACTOR'S RESPONSIBILITY TO OBTAIN COPIES OF THE ABOVE STANDARDS SPECIFICATIONS AND DRAWINGS, AS WELL AS ALL OTHER STANDARDS AND SPECIFICATIONS WHICH MAY BE NECESSARY TO COMPLETELY AND ACCURATELY INTERPRET THESE PLANS.
- HOLD HARMLESS AND INDEMNIFICATION CLAUSE THE CONTRACTOR SHALL AGREE THAT IN ACCORDANCE WITH GENERALLY ACCEPTED CONSTRUCTION PRACTICES, THE CONTRACTOR SHALL BE REQUIRED TO ASSUME SOLE AND COMPLETE RESPONSIBILITY FOR JOB SITE CONDITIONS DURING THE COURSE OF CONSTRUCTION OF THE PROJECT, INCLUDING SAFETY TO ALL PERSONS AND PROPERTY; THAT THIS REQUIREMENT SHALL BE MADE TO APPLY CONTINUOUSLY AND NOT BE LIMITED TO NORMAL WORKING HOURS; AND THAT THE CONTRACTOR SHALL DEFEND INDEMNIEY AND HOLD THE LANDSCAPE ARCHITECT HARMLESS FROM ANY AND ALL LIABILITY; REAL OR ALLEGED, IN CONNECTION WITH THE PERFORMANCE OF WORK ON THIS PROJECT, EXCEPTING FOR LIABILITY ARISING FROM THE SOLE NEGLIGENCE OF THE LANDSCAPE ARCHITECT.
- UNAUTHORIZED CHANGES TO DRAWINGS THE LANDSCAPE ARCHITECT SHALL NOT BE RESPONSIBLE FOR, OR LIABLE FOR, UNAUTHORIZED CHANGES TO OR USE OF DRAWINGS. CHANGES TO THE PLANS MUST BE IN WRITING AND MUST BE APPROVED BY LANDSCAPE ARCHITECT PRIOR TO COMMENCEMENT OF
- UNDERGROUND SERVICE ALERT NOTIFY BLUE STAKE 48 HOURS PRIOR TO DIGGING AT 1-800-STAKE-IT. EXERCISE EXTREME CARE IN WORKING NEAR EXISTING UTILITIES. VERIFY THE LOCATION AND CONDITION OF UTILITIES PRIOR
- 6. INSPECTIONS NOTIFY OWNER REPRESENTATIVE AND APPROPRIATE AGENCY REPRESENTATIVE AT LEAST 48 HOURS IN ADVANCE PRIOR TO REQUIRED
- QUANTITIES INDICATED IN DRAWINGS ARE PROVIDED AS A COURTESY ONLY. VERIFY QUANTITIES SHOWN BY CONDUCTING A INDEPENDENT QUANTITY TAKE
- OWNER AND LANDSCAPE ARCHITECT WILL DECIDE QUESTIONS RELATING TO INTERPRETATION OF DRAWINGS AND ACCEPTABLE FULFILLMENT OF THE WORK SHOWN IN CONTRACT DOCUMENTS.
- 9. MAINTAIN PREMISES CLEAN AND FREE OF EXCESS EQUIPMENT, MATERIALS, AND RUBBISH INCIDENTAL TO THE WORK AT ALL TIMES INCLUDING WEEKENDS AND HOLIDAYS DISPOSE OF RUBBLE TRASH OR DISPOSABLE ITEMS RESULTING FROM DEMOLITION IN A LEGAL, LAWFUL, AND SAFE MANNER TO AN

- APPLY PRE-EMERGENT AFTER COMPLETION OF EARTHWORK, LEACHING, BED
- ALL EXISTING LANDSCAPE AREAS OUTSIDE THE PROJECT AREA THAT ARE DISTURBED BY ANY ACTIVITY UNDER THIS CONTRACT SHALL BE REPAIRED TO EQUAL OR BETTER CONDITION AND TO THE SATISFACTION OF THE OWNER AT THE CONTRACTORS EXPENSE.
- THE CONTRACTOR SHALL PROVIDE FLAGGED AND/OR STAKED LAYOUT OF ALL PLANTING LOCATIONS FOR REVIEW AND ADJUSTMENT, IF NECESSARY, BY THE OWNER'S REPRESENTATIVE PRIOR TO STARTING IRRIGATION OR PLANT PIT EXCAVATIONS.
- 13. ANY AND ALL PLANTS OR TREES, NOT DESIGNATED TO BE REMOVED, WHICH ARE DISTURBED OR DAMAGED AS A RESULT OF WORK UNDER THIS CONTRACT SHALL BE REPLACED AT CONTRACTOR'S EXPENSE WITH A PLANT OF EQUAL OR BETTER QUALITY AND OF THE SAME SIZE AND SPECIES OF THE ORIGINAL EXISTING PLANT UNLESS OTHERWISE DIRECTED BY THE OWNER'S REPRESENTATIVE
- CONTRACTOR SHALL FINE GRADE AREAS PRIOR TO PLANTING. FINE GRADING SHALL INCLUDE THE REMOVAL OF DEBRIS, ROCKS, ETC., FROM THE SITES, FORMING LOW-FLOW CHANNEL FOOTPRINTS AS NOTED ON THE PLANS. BACKFILLING BEHIND BOULDERS ON LOW-FLOW CHANNEL SLOPES, AND ENSURE POSITIVE DRAINAGE.
- CONTRACTOR SHALL PROVIDE POSITIVE DRAINAGE AWAY FROM BUILDINGS, WALLS, UTILITY EQUIPTMENT, ETC.
- PLANT MATERIAL LOCATIONS SHALL BE STAKED IN THE FIELD BY THE CONTRACTOR AND APPROVED BY THE ENGINEER PRIOR TO INSTALLATION.
- THE IRRIGATION SYSTEM IS TO BE FULLY OPERATIONAL AND EFFECTIVE PRIOR TO THE INSTALLATION OF PLANT MATERIAL.

## TOWN OF GILBERT GENERAL NOTES

- ALL DESIGN AND CONSTRUCTION MUST BE IN ACCORDANCE WITH THE UNIFORM STANDARD SPECIFICATIONS AND DETAILS PUBLISHED BY THE MARICOPA ASSOCIATION OF GOVERNMENTS AS AMENDED BY THE TOWN OF GILBERT (LATEST VERSION)
- THE CONTRACTOR SHALL NOTIFY THE TOWN OF GILBERT ENGINEERING DEPARTMENT AT LEAST 24 HOURS IN ADVANCE OF ANY CONSTRUCTION FOR
- PLACEMENT OF DRIVEWAYS SHALL NOTE BE IN CONFLICT WITH UTILITY
- CONTRACTOR SHALL BE RESPONSIBLE FOR THE COORDINATION OF THE RELOCATION OF POWER POLES AND OTHER UTILITIES.
- CONTRACTOR TO ADJUST ALL VALVES, MANHOLES, CLEANOUTS, ETC. BOTH NEW AND OLD TO FINISH PAVEMENT GRADE PER STANDARD DETAILS.
- ENGINEER CERTIFIES THAT HE HAS CONTACTED ALL INTERESTED UTILITY COMPANIES AND HAS TRANSFERRED ALL EXISTING, AND/OR PROPOSED UTILITY LINES AND RELATED INFORMATION ONTO THESE PLANS, AND THAT HE HAS ALSO CORRECTLY PLOTTED THE EXISTING AND PROPOSED RIGHT-OF-WAY EASEMENT
- ALL IMPROVEMENTS WITHIN THE RETENTION BASIN AND/OR ROADWAY PARKWAYS SHALL BE IN ACCORDANCE WITH THE LATEST TOWN OF GILBERT PROCEDURES FOR DEVELOPERS AND ENGINEERS
- CONTRACTOR IS ADVISED THAT AN EXCAVATION AND DIRT MOVING PERMIT IS REQUIRED BY THE MARICOPA COUNTY HEALTH DEPARTMENT AND THE TOWN OF GILBERT, IT SHALL BE THE RESPONSIBILITY OF THE CONTRACTOR TO OBTAIN THIS PERMIT AND COMPLY WITH ITS REQUIREMENTS
- ALL LANDSCAPING SHALL COMPLY WITH TOWN OF GILBERT STANDARDS DETAIL 92 OR 93 (WHICHEVER IS APPLICABLE) AT TIME OF INSTALLATION. ALL SPRINKLER AND LANDSCAPE WORK MUST BE INSTALLED IN ACCORDANCE WITH THE LATEST EDIT**I**ON OF THE TOWN OF GILBERT PROCEDURE MANUAL
- 10. NO WALLS, BUILDINGS, OR OBSTRUCTIONS TO VIEW IN EXCESS OF TWO (2) FEET IN HEIGHT SHALL BE PLACED ON ANY CORNER LOT WITHIN A TRIANGULAR AREA FORMED BY THE CURB LINES AND A LINE CONNECTING THEM AT POINTS 33 FEET FROM THE INTERSECTION OF THE CURB LINES. TREES MAY BE LOCATED WITHIN IN THE TRIANGLE PROVIDED THEY ARE PRUNED HIGH ENOUGH (7 FOOT MIN.) TO PERMIT UNOBSTRUCTED VIEW, SEE TOWN OF GILBERT STANDARD DETAIL 92
- ALL RETENTION BASINS MUST DRAIN ANY STORM EVENT UP TO AND INCLUDING THE 50 YEAR 24-HOUR STORM WITHIN N36 HOURS, OWNER(S) OF ANY BASIN. FAILING TO MEET THIS REQUIREMENT MUST TAKE CORRECTIVE ACTION TO BRING THE BASIN INTO COMPLIANCE.

- CALL THE BLUE STAKE CENTER (602) 263-1100 48 HOURS BEFORE YOU DIG FOR OCATION OF UNDERGROUND UTILITIES.
- CONTROL PLAN APPLICATION AND PERMIT APPLICATION AT LEAST 48 HOURS IN ADVANCE OF THE ANTICIPATED START OF CONSTRUCTION ACTIVITIES. EXCAVATION AND CONSTRUCTION WORK WILL NOT BE PERMITTED IN PUBLIC

13. A TRAFFIC CONTROL PLAN SHALL BE SUBMITTED ALONG WITH A TRAFFIC

- RIGHT-OF-WAY OR PUBLIC UTILITY EASEMENTS ON SATURDAY, SUNDAY, OR LEGAL HOLIDAYS UNLESS APPROVED BY THE TOWN ENGINEER.
- 15. PERMITS ARE REQUIRED FOR THE FOLLOWING: TRAFFIC SIGNAL INSTALLATION; TRAFFIC SIGNAL INTERCONNECT; SIGNING; PERMANENT MARKERS; AND TEMPORARY TRAFFIC CONTROL.
- TRAILS SIGNS SHALL BE INSTALLED AT A MINIMUM OFFSET OF 20' FROM THE TOP OF THE CANAL BANK. TRAIL SIGNS SHALL BE MOUNTED ON A 48" POST AND FOUNDATION, PER TOWN OF GILBERT DETAIL 79. THE COST OF THE POST AND FOUNDATION SHALL BE INCLUDED IN ITEM NUMBER 464 02010

## LANDSCAPE ARCHITECT

HARRINGTON PLANNING + DESIGN (HP+D) 1921 S. ALMA SCHOOL RD. MESA, AZ 85210 JASON HARRINGTON, RLA, ASLA, ASIC, APWA (480) 250-0116 JASON@HARRINGTONPLANNINGDESIGN.COM

## OWNER CONTACT

BUSHTEX SATELLITE 723 W GUADAUI PE RD ADELAIDA SEVERSON ADELAIDA@BUSHTEX.COM

## SITE ADDRESS

723 W GUADALUPE ROAD GILBERT, ARIZONA 85233

APN: 302-15-001E, 302-15-001L

## PLANTING MATERIAL LEGEND




LANDSCAPE MATERIALS

Decomposed Granite, 1/2" screened, Madison Gold, 2" deep in

\*ADWR = Arizona Department of Water Resources Approved Low-Water Use Plant

## \*SVT = Sight Visibilty Triangle VICINITY MAP

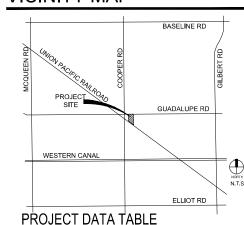

GROSS SITE AREA TOTAL\*: 137,378 SF / 3.153 AC NET SITE AREA TOTAL\*: 121.532 SF LANDSCAPE AREA TOTAL: 70,260 SF ON-SITE LANDSCAPE AREA: 17,389 SF OFF-SITE LANDSCAPE AREA: 52,871 SF % LANDSCAPE COVERAGE DIVIDED BY NET SITE AREA)

	PROVIDED AREA	REQ'D PLANTS	PROVIDED PLANTS
ARTERIAL FRONTAGE 1 TREE/25 LF FRONTAGE 3 SHRUBS PER TREE	239 LF FRONTAGE	10 TREES 30 SHRUBS	11 TREES 81 SHRUBS
DADKING LOT (EV. FINGE	DICLANDO ADELEO	C THAN ANAL	

PARKING LOT (EX. FINGER ISLANDS ARE LESS THAN 4'W)

1 TREE/ISLAND 1 ISLANDS 1 TREES 1 TREES 1 ISLANDS 3 SHRUBS PER TREE

## DESCRIPTION OF WORK

\*iNCLUDES PARCELS 1 & 2

LANDSCAPE WORK FOR THIS PROJECT WILL CONSIST OF ADDITIONAL PLANTING IN THE FRONTAGE AND PARKING LOT AREA. DECOMPOSED GRANITE GROUNDCOVER SHALL BE USED IN ALL PLANTING AREAS. AN AUTOMATIC DRIP IRRIGATION SYSTEM SHALL BE INSTALLED TO PROVIDE ADEQUATE WATER TO PLANTS. EXISTING PLANTING IN SOUTH RETENTION AREA IS TO REMAIN AND IRRIGATION FOR THAT AREA WILL BE CONNECTED TO NEW SYSTEM FOR FRONTAGE AND PARKING LOT.

> CENTER ALL TWO WORKIN .800.782.5348

BU **Attachment** R20  $\overline{\Delta}$ BUILDIN

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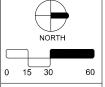
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REV. COMMENT DATE Prelim Submitta 02.27.2 ISSUE PRELIMINARY

LANDSCAPE PACKAGE FEBRUARY 27, 2020


DRAWN BY: SAJ CHECK BY: JEH PROJ. NO.: 2020-006 CASE NO.:




**PRELIMINARY** LANDSCAPE PLAN

1 of 1

## DR20-47 Bushtex Attachment 6: Grading & Drainage

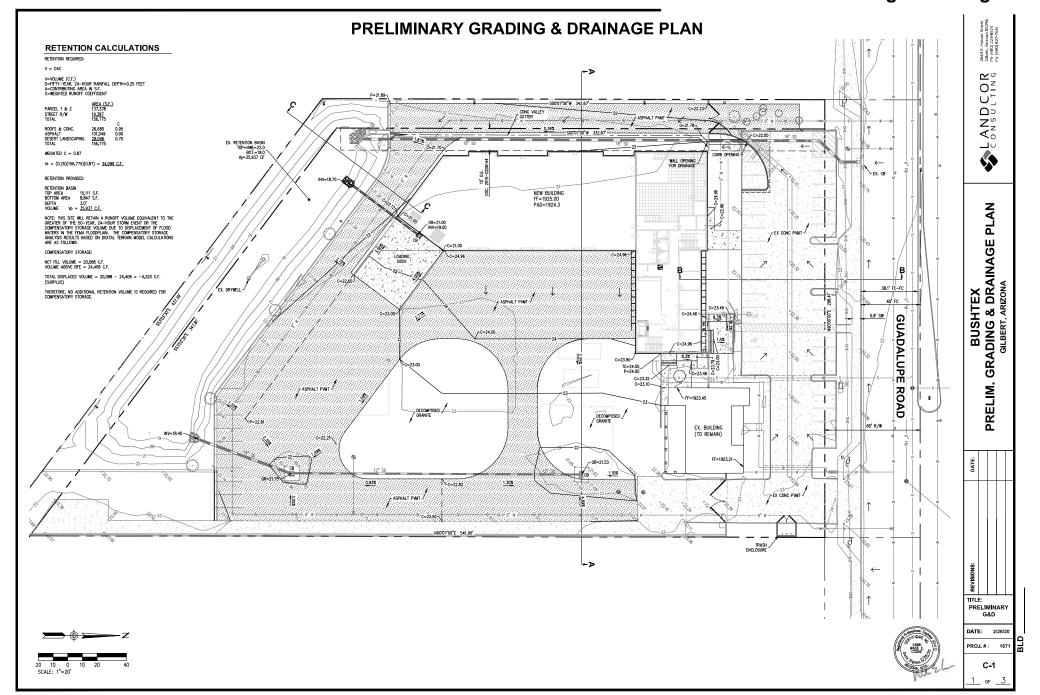

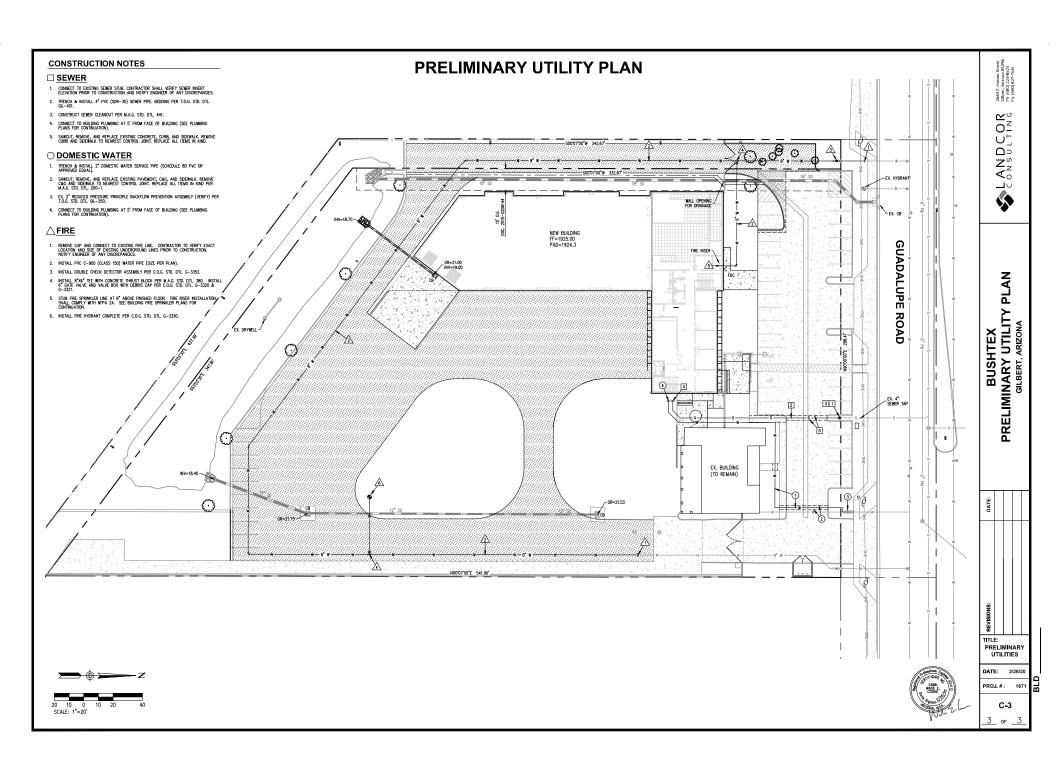

## **CROSS SECTIONS** BUILDING FG=22.03 EX. CRADE -2+00 0+80 1+00 1+20 2+20 2+40 2+60 2+80 3+00 3+20 SECTION A-A GUADALUPE ROAD FF=25.00 EX. CONCRETE SECTION B-B FF=25.00 0+20 SECTION C-C



REVISIONS:			
	E: CR ECT		

DATE: 2/26/20
PROJ.#: 1671
C-2

## DR20-47 Bushtex Attachment 7: Colors & Materials



TILT-WALL OR STUCCO SHERWIN WILLIAMS IVOIRE SW 6127



TILT-WALL OR STUCCO SHERWIN WILLIAMS INDEPENDENT GOLD SW 6401




TILT-WALL OR STUCCO OR METAL COLOR TO MATCH LOGO OF CLIENT, BUSHTEX


GLAZING


SOLAR BAN 70XL - GREEN




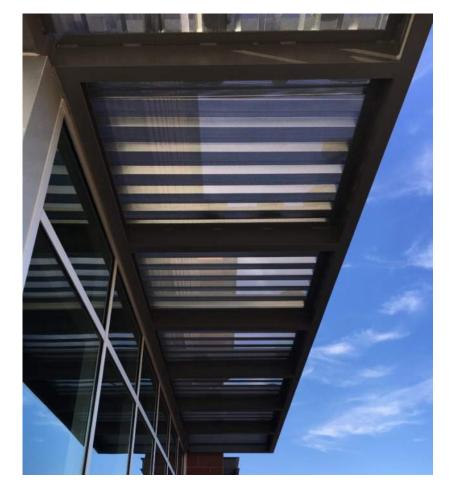



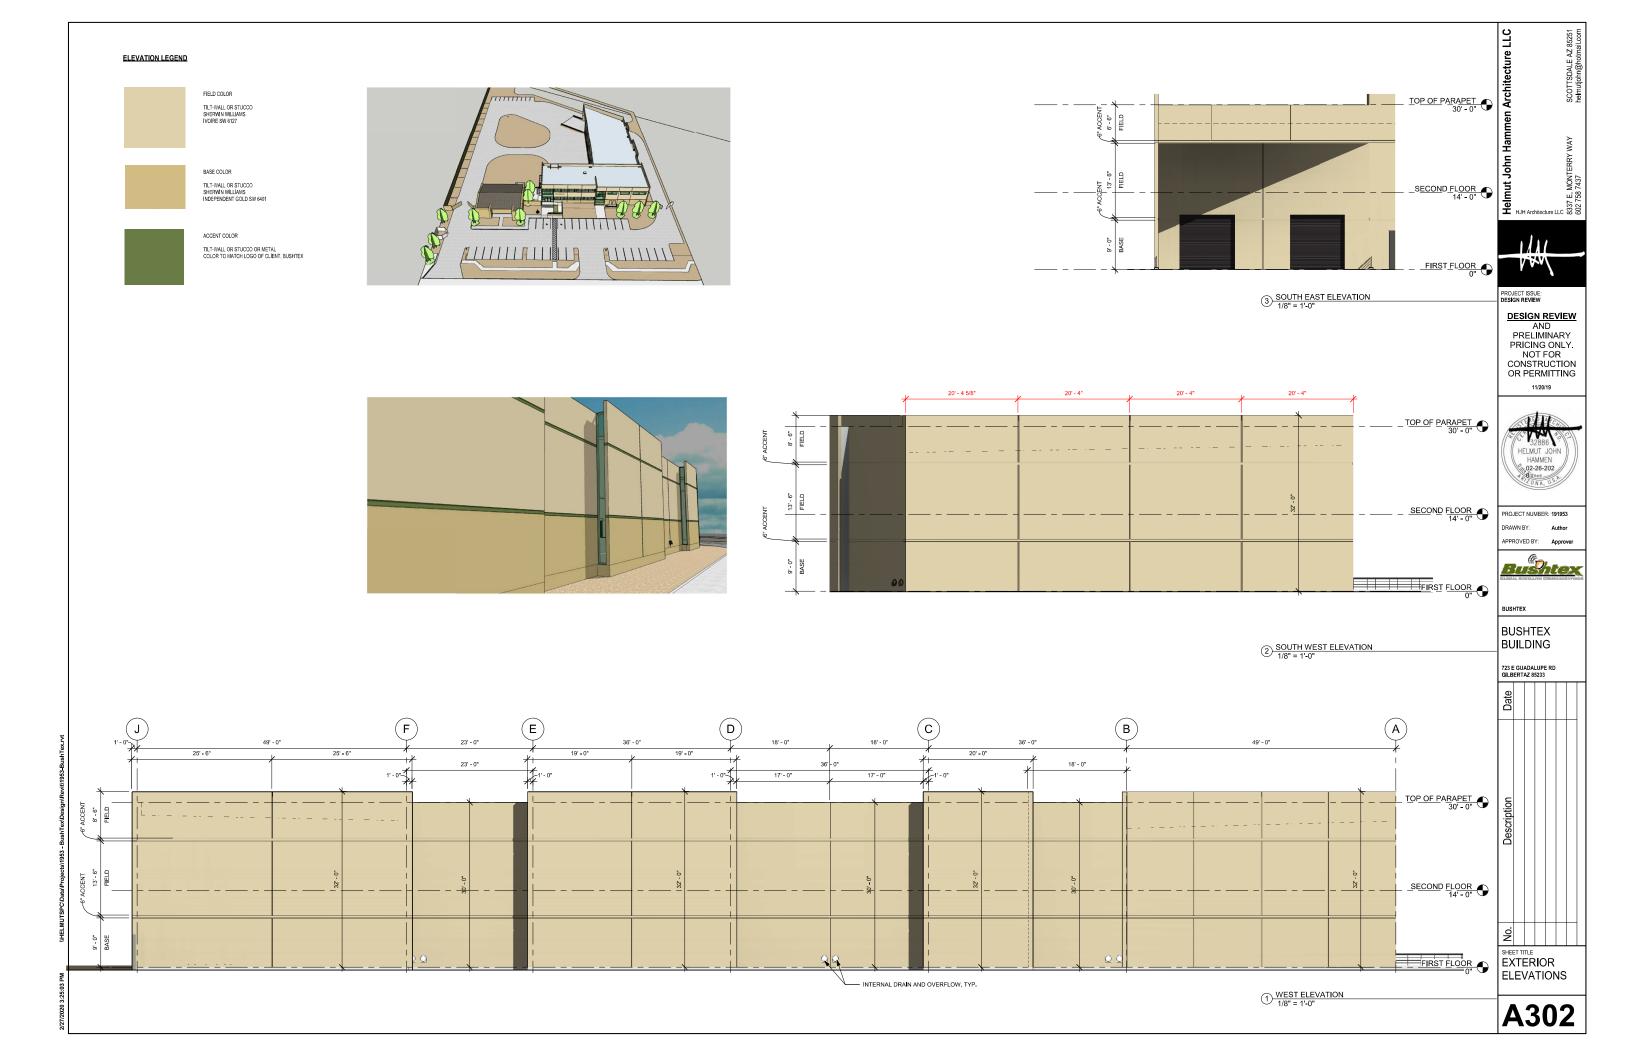

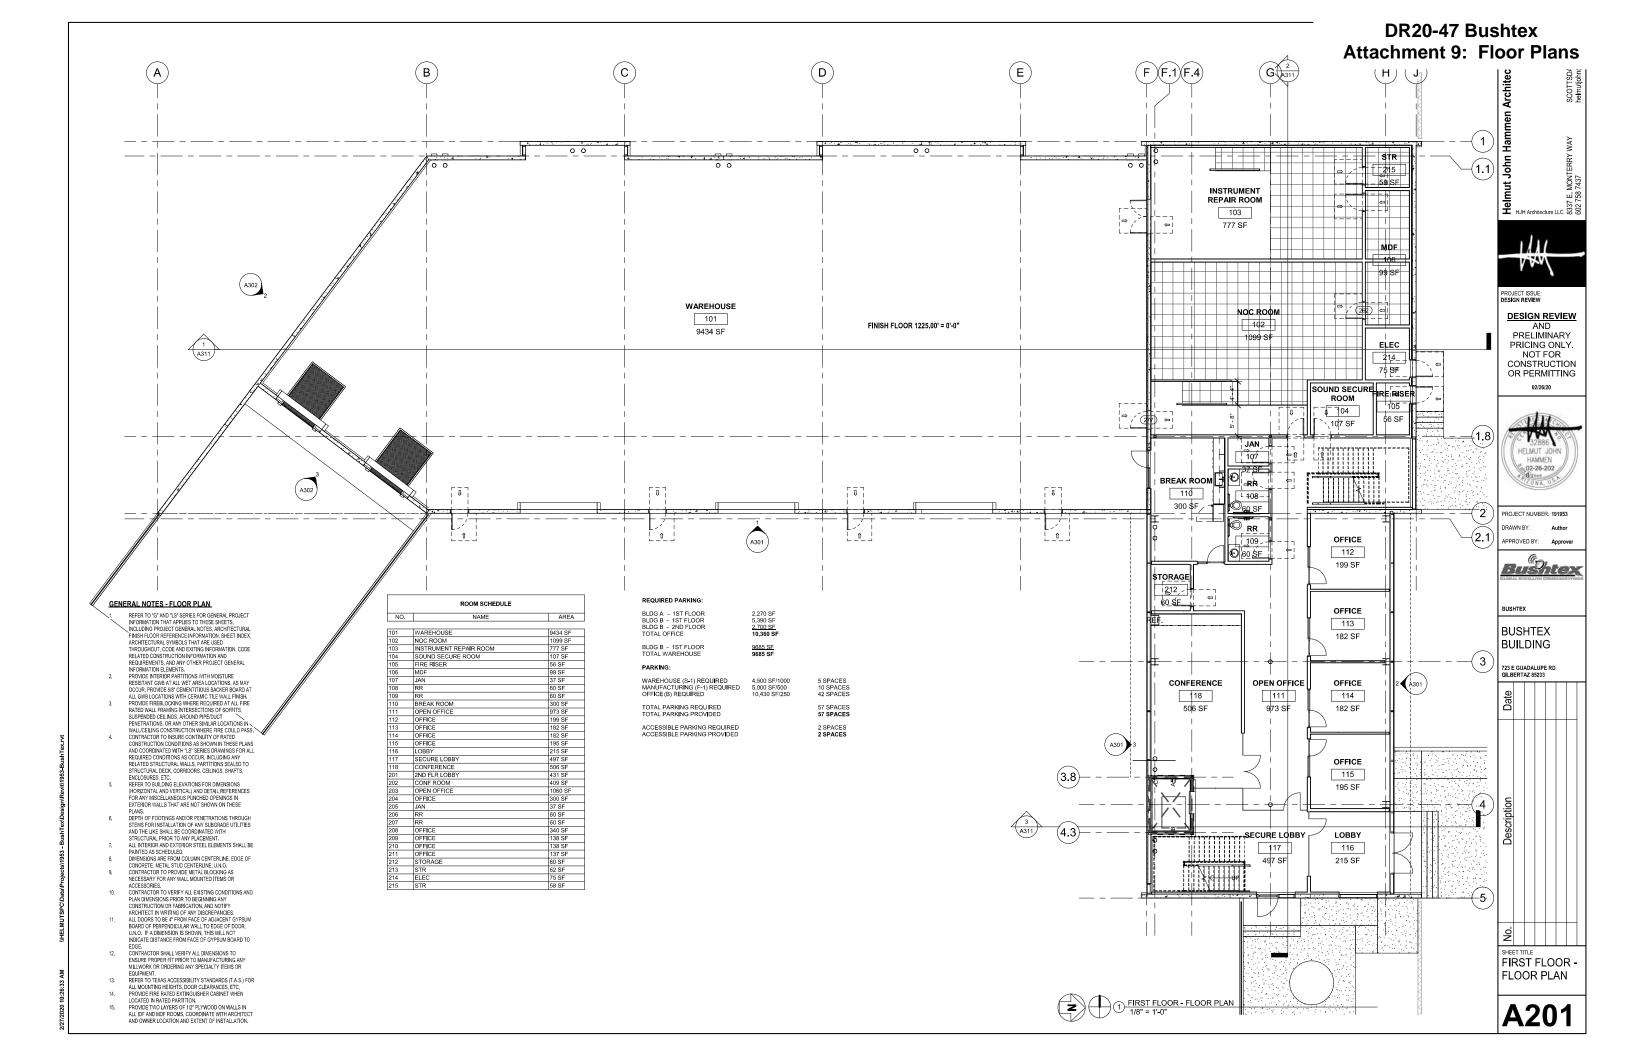

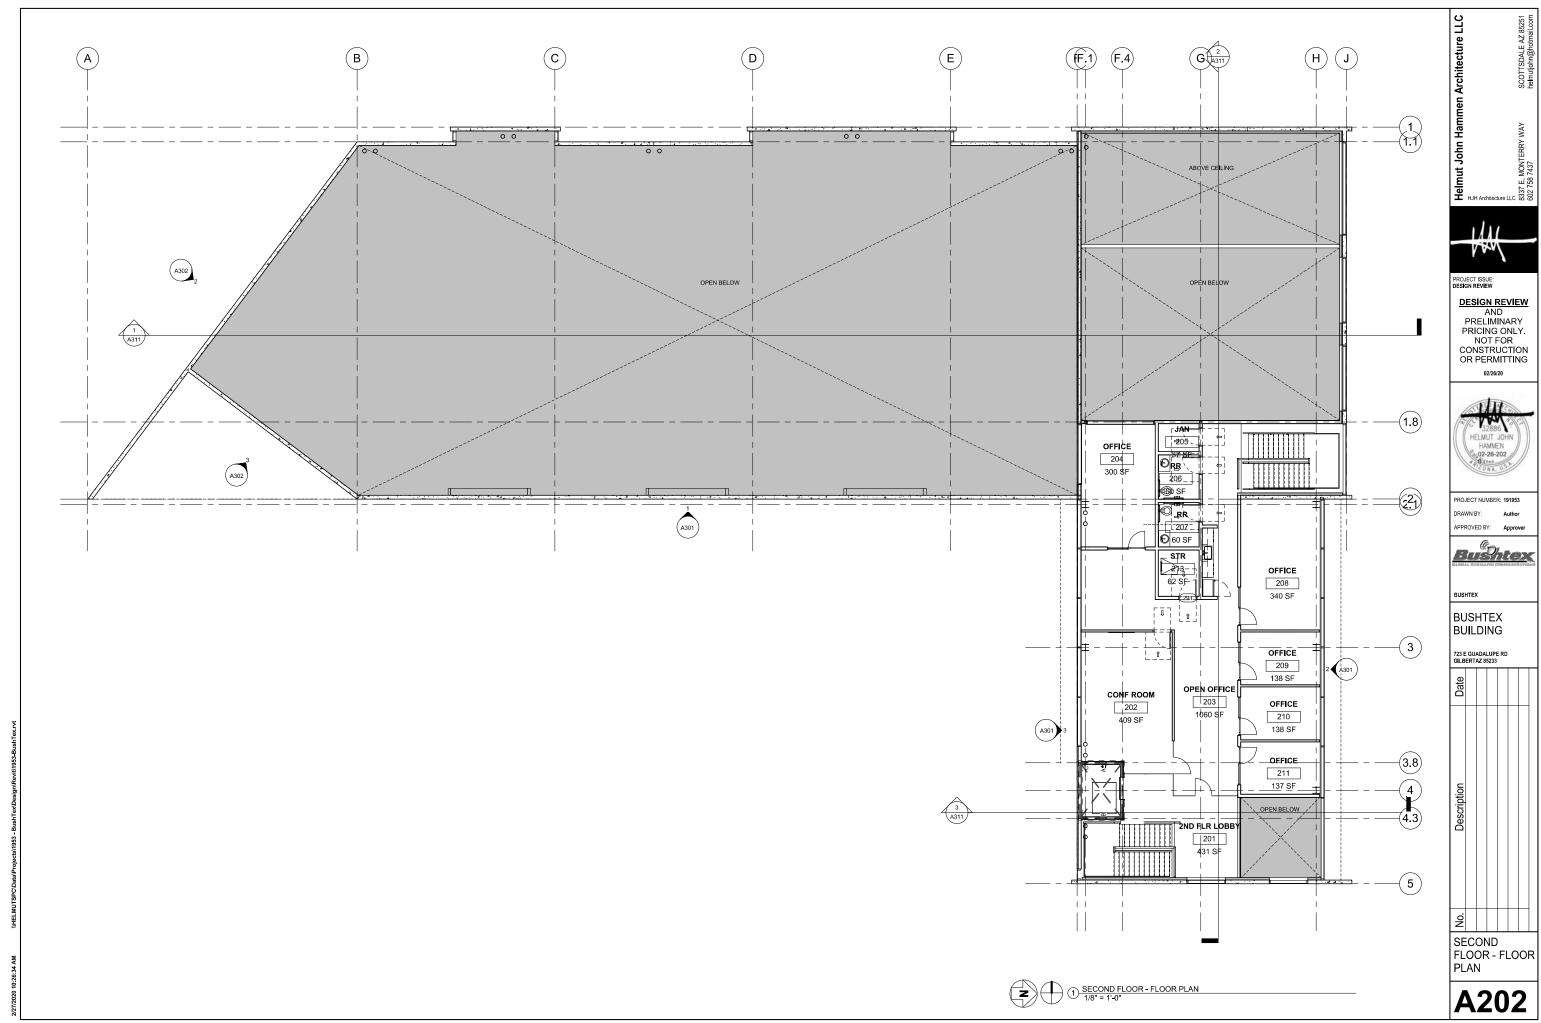



## DR20-47 Bushtex SCHEDULE: **Attachment 10: Lighting** SA ₽ ₽ SB SC 무 SD 무 SE STATISTICS: Avg Max Min Max/Min Avg/Min SITE TRUCK DOCK RAMP + 1.8 fc 13.3 fc 0.0 fc N/A N/A 7.1 fc 8.8 fc 5.2 fc 1.4:1 1,7:1

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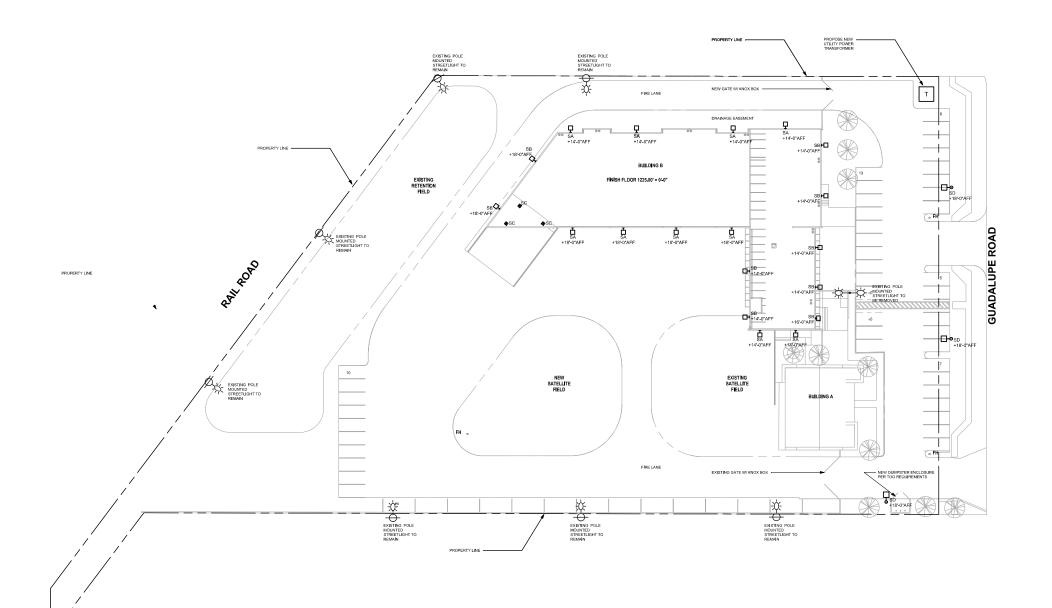



PH100



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- E.P.A. RATINGS SHALL BE COORDINATED WITH POLE AND FIXTURE ASSEMBLY.
- GENERAL CONTRACTOR TO PROVIDE POLE BASE DESIGN SEALED BY PROFESSIONAL STRUCTURAL ENGINEER. REFER TO STRUCTURAL DRAWINGS FOR POLE BASE DETAIL. 3. CONNECT TO REBAR WITH APPROVED LISTED GROUNDING CLAMPS USED FOR THIS PURPOSE.

BUSHTEX

BUSHTEX BUILDING

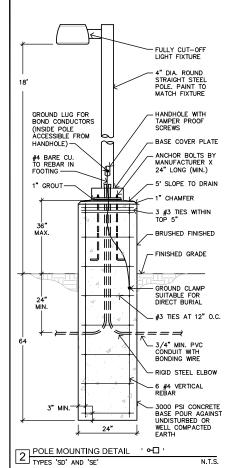PROJECT ISSUE:
SCHEMATIC DESIGN
BASIS OF
DESIGN REVIEW
AND
PRELIMINARY
PRICING ONLY.

NOT FOR

45684 PAUL D. HALUM

PROJECT NUMBER:191953

Bushtex

PPROVED BY:

CONSTRUCTION OR PERMITTING

723 E GUADALUPE RD GILBERTAZ 85233




SHEET TITLE ELECTRICAL SITE LIGHTING PLAN

E100

CeDesign Group

1" = 30'-0"



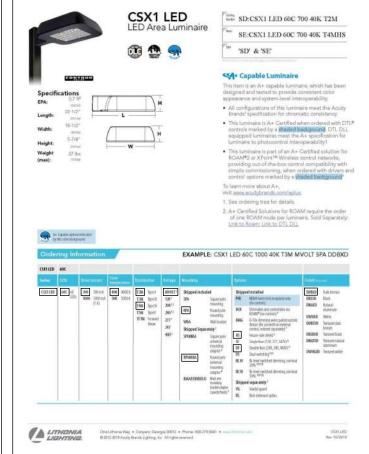

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CSXI-LED Rev 10/20/16

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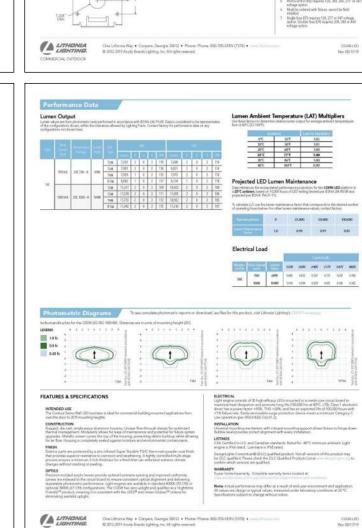
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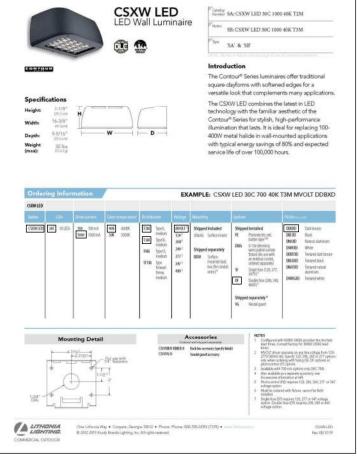
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en Architecture LLC		SCOTTSDALE AZ 85251	helmutjohn@hotmail.com
Helmut John Hammen Architecture LLC	HJH Architecture LLC	8337 E. MONTERRY WAY	602 758 7437
	<del>WW.</del>		



PROJECT ISSUE: SCHEMATIC DESIGN BASIS OF DESIGN REVIEW PRELIMINARY PRICING ONLY. CONSTRUCTION OR PERMITTING 11/20/19



PROJECT NUMBER:191953 DRAWN BY: Author APPROVED BY: Approve



BUSHTEX

BUSHTEX BUILDING

723 E GUADALUPE RD GILBERTAZ 85233

Date			
Description			
9			

SHEET TITLE SITE LIGHTING FIXTURE

CUTSHEETS E101

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Phoenix, AZ 85016